SYCAMORE SINGLE TRACK TRAIL IMPROVEMENTS 2024

MADISON, WI

CONTRACT #9503 ACCOUNT #14933-51-130 NOVEMBER, 2023

OWNER

City of Madison - Parks Division
Contact: Corey Stelljes
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CONSULTANTS

IMBA Trail Solutions
Mike Repyak, Director
Tim Halbakken, PM,
tim.halbakken@imba.com

SUBMITTALS

Bid Documents



PROJECT LOCATION: 830 JANA LN

MADISON, WI 53904

INDEX OF SHEETS

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CP-01	CONSTRUCTION NOTES
SP-01	OVERALL SITE PLAN
SP-02	PLAN ENLARGEMENT
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EC-02	EROSION CONTROL PLAN ENLARGEMENT
DT-01	DETAILS
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SYCAMORE PAR MADISON, WI

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PROJECT No. CMPR230:
ORIGIN DATE: 10.31.23

DRAWN BY: TJH/RMH
CHECKED BY: MR

| ISSUED FOR:
No.	DATE	COMMENT
A	10/31/23	90% DD -- CHECK SET
B	11/21/23	90% DD -- CHECK SET
C	11/29/23	90% DD -- CHECK SET


SHEET NUMBER:

CP-00

VICINITY MAP

NOT TO SCALE

DRAWING SET ABBREVIATIONS SD STORM DRAIN MECH MECHANICAL AGGREGATE BASE COURSE AREA DRAIN **EQUIP EQUIPMENT** MED MEDIUM SECT SECTION ADJ **ADJACENT** ESC **ESCALATOR** MEZZ MEZZANINE SQUARE FEET AFF ABOVE FINISH FLOOR **EXIST EXISTING** MFR MANUFACTURER SHT SHEET ALT **ALTERNATE** EXP MH MANHOLE SIM SIMILAR **EXPOSED** STRUCTURAL INSULATION PANEL ALUM **ALUMINIUM EXPANSION** MIN MINIMUM **SEALER** SLR ANODIZED **EXTERIOR** MISC **MISCELLANEOUS** SNK SINK **APPROX APPROXIMATE** FLOOR DRAIN MILLWORK FDN **SPECIFICATION** ARCH **ARCHITECTURAL FOUNDATION** MO MTD MASONRY OPENING B&B BALL AND BURLAP FINISH(ed) SQUARE MOUNTED STAINLESS STEEL B/O FL **FLOOR** MTL FLG **FLANGE** SSK SERVICE SINK BACK OF CURB NORTH N/A NIC NO NOM **FLASHING** STA STAINED NOT APPLICABLE BLW BELOW **FLOOR** NOT IN CONTRACT STD STANDARD BLDG BUILDING STIFFENER STIFF BLKG **BLOCKING FLUORESCENT** BM BOT BRG FACE OF CONCRETE NOMINAL STL STEEL NTS OA OC OD OFD FOF STAMPED FACE OF FINISH STMP BOTTOM NOT TO SCALE FOS FACE OF STUD STN STONE BEARING **OVERALL** BRK BRICK FR FIRE-RETARDANT ON CENTER STOR STORAGE BS BW C/C **BOTTOM OF STEP OUTSIDE DIAMETER** STRUCT STRUCTURAL BOTTOM OF WALL FTG **FOOTING** SUSP SUSPENDED OVERFLOW DRAIN CENTER TO CENTER OPNG OPP OSB OSF OZ PA GAUGE TREAD **OPENING** CAL TREE CALIPER **GALLON** TOP OF STRUCTURAL SLAB **OPPOSITE** TSS CUBIC FEET PER MINUTE ORIENTED STRAND BOARD GALVANIZED TOP OF STRUCTURAL FLOOR CIP CAST IN PLACE GC **OUTSIDE FACE** GENERAL CONTRACTOR TOP OF FINISH FLOOR CONTROL JOINT CJ **GALVANIZED IRON** OUNCE TOC TOP OF CURB CENTER LINE CL PAINTED **GL BLK GLASS BLOCK** TEL **TELEPHONE** CLG CLR **PARTITION** THICKNESS THK PAV **PAVERS** GLASS MESH MASONARY UNIT THRU THROUGH CM CORRUGATED METAL POINTS OF CURVATURE GND GROUND TOB TOP OF BEAM CMP CORRUGATED METAL PIPE GR GRANITE PRECAST CONCRETE TOP OF CONCRETE CMU CONCRETE MASONRY UNIT PERPENDICULAR TW TOP OF WALL CO **CLEAN OUT HEATING & VENTILATION TRANS TRANSVERSE** COL COLUMN HB **PLUMBING** HOSE BIB TOP OF STEP CONC CONCRETE HC **HOLLOW CORE** PLSTC TYP TYPICAL CONST CONSTRUCTION **HARDWARE** PLWD PLYWOOD UNDERGROUND CONTINUOUS PNT PAINTED HM HOLLOW METAL CORR CS CU UNDERWRITER'S LAB CORRUGATED PPL PROPERTY LINE HHHAND HEWN UNO UNLESS NOTED OTHERWISE CONCRETE SEALER HORIZONTAL UR URINAL HIGH POINT **PREFABRICATE VERTICAL CUBIC YARD VERT** HOURS PROJECTION **VEST** VESTIBULE PSF POUNDS PER SQUARE FOOT **HEIGHT** DD **DECK DRAIN** VERIFY IN FIELD PSI POUNDS PER SQUARE INCH INSIDE DIAMETER DF DRINKING FOUNTAIN **VENEER** PT PRESSURE TREATED **INCHES** DRAIN INLET WEST POLYVINYL CHLORIDE INCLUDE DIAMETER WATER CLOSET INFORMATION DIAG DIAGONAL WOOD INSULATION DIM DIMENSION RD REF **ROOF DRAIN** WALLS WLS INT **INTERIORS** DOWN REFERENCE WATERPROOF DOWNSPOUT REFR REFRIGERATOR WATERPROOF MEMBRANE LABORATORY DTL DWG REINF REINFORCED WATER RESISTANT LAMINATED DRAWING WATER SURFACE REQD REQUIRED LAV LAVATORY REV RM RO RP REVISION WELDED WIRE FABRIC WWF **POUNDS** ROOM WHITE WATER PARK LOW POINT EXPOSED CONSTRUCTION **ROUGH OPENING** YDS YARDS LIGHT **EXPANSION JOINT** RADIUS POINT LIGHTWEIGHT **ELEC ELECTRICAL ROUGH SAWN** LOUVER **ELEV ELEVATION** SOUTH MACHINE **ELEVR ELEVATOR** SOLID CORE MATERIAL EM **EMERGENCY** SCH SCHEDULE **MAXIMUM** GRAPHIC SYMBOLS LEGEND

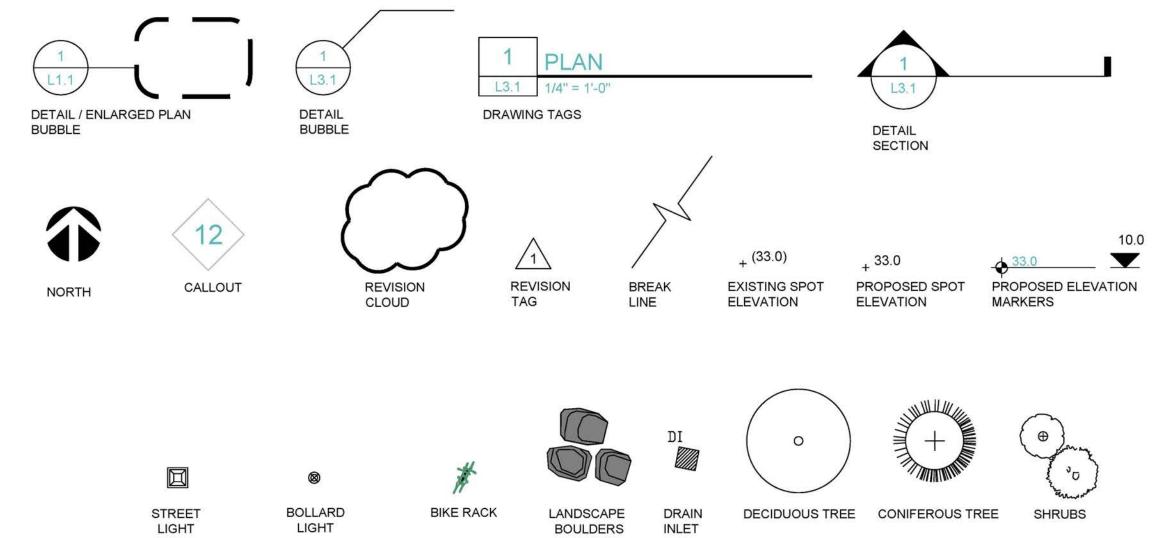

SUMMARY OF WORK

These Bid Documents provide the layout and details necessary for the City of Madison to proceed with the RFP process for all bike and trails related amenities for the project area.



SYCAMORE PARK MADISON, WI

NOTES

STRUCTION

CON


PROJECT No. CMPR2302
ORIGIN DATE: 10.31.23
DRAWN BY: TJH/RMH
CHECKED BY: MR


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No.	DATE	COMMENT
Α.	10 /21 /07	200 DD 01150


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A	10/31/23	90% DD - CHECK SET
В	11/21/23	90% DD - CHECK SET
C	11/29/23	90% DD - CHECK SET


SHEET NUMBER:


CP-01

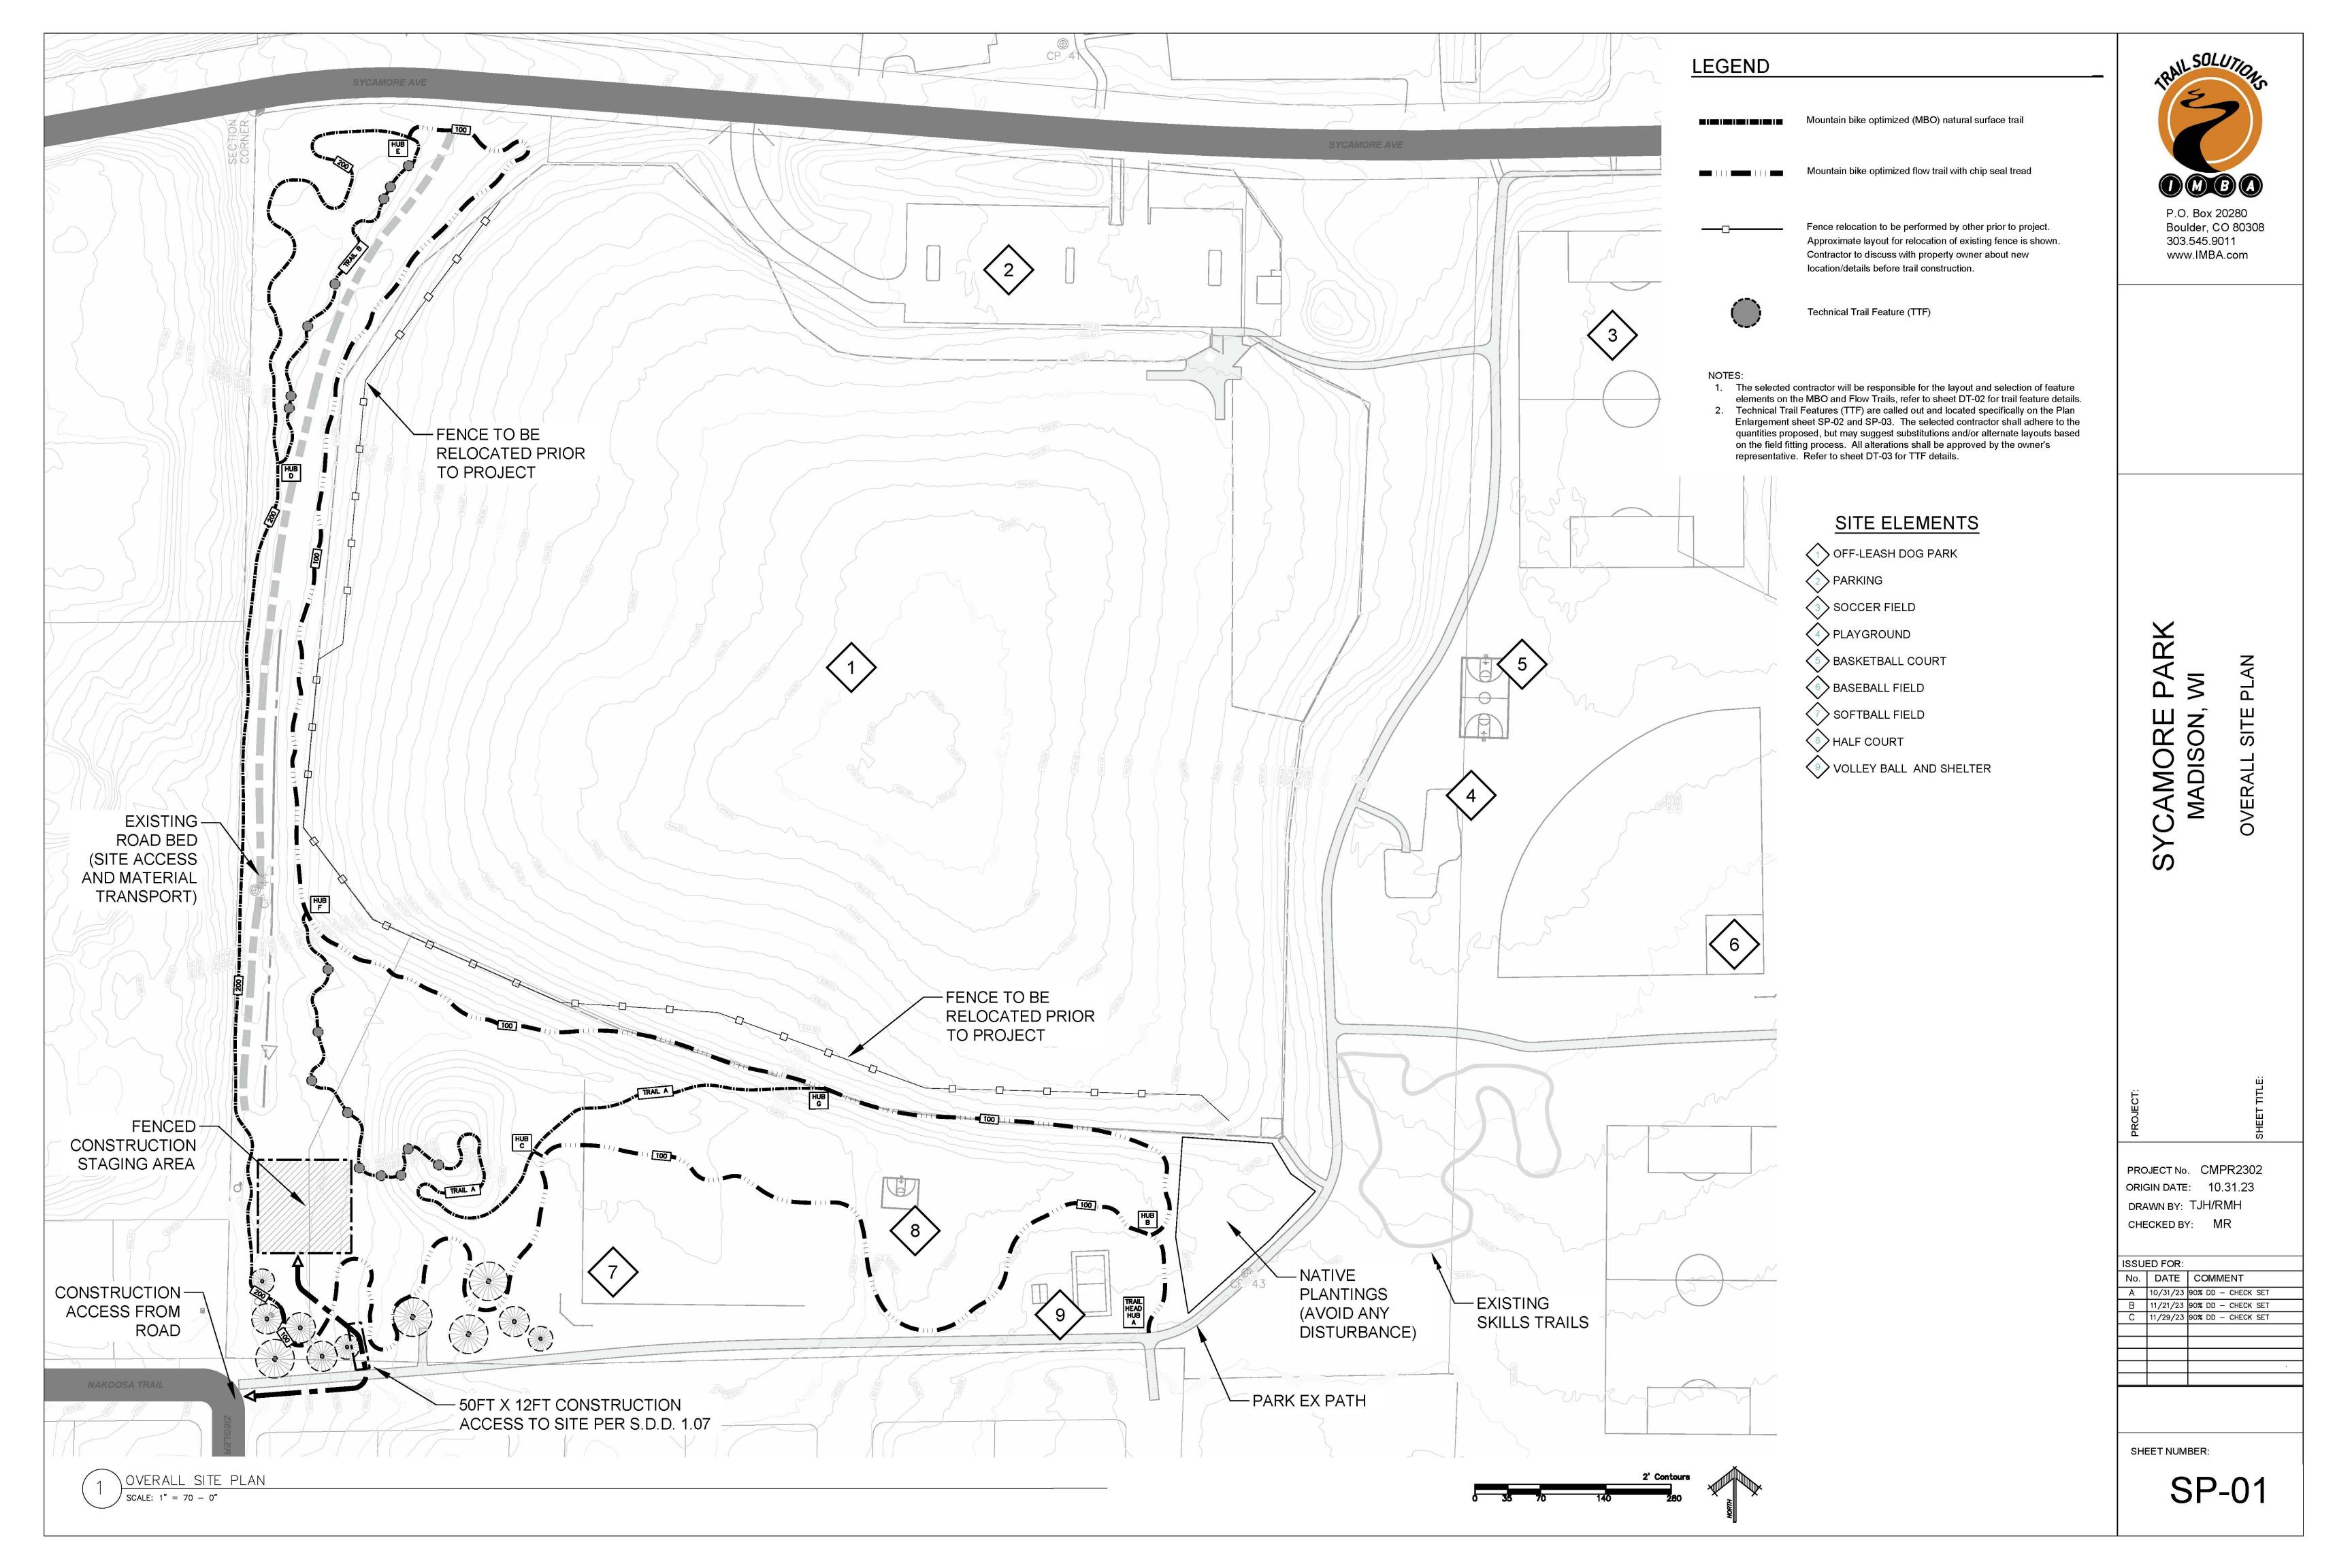


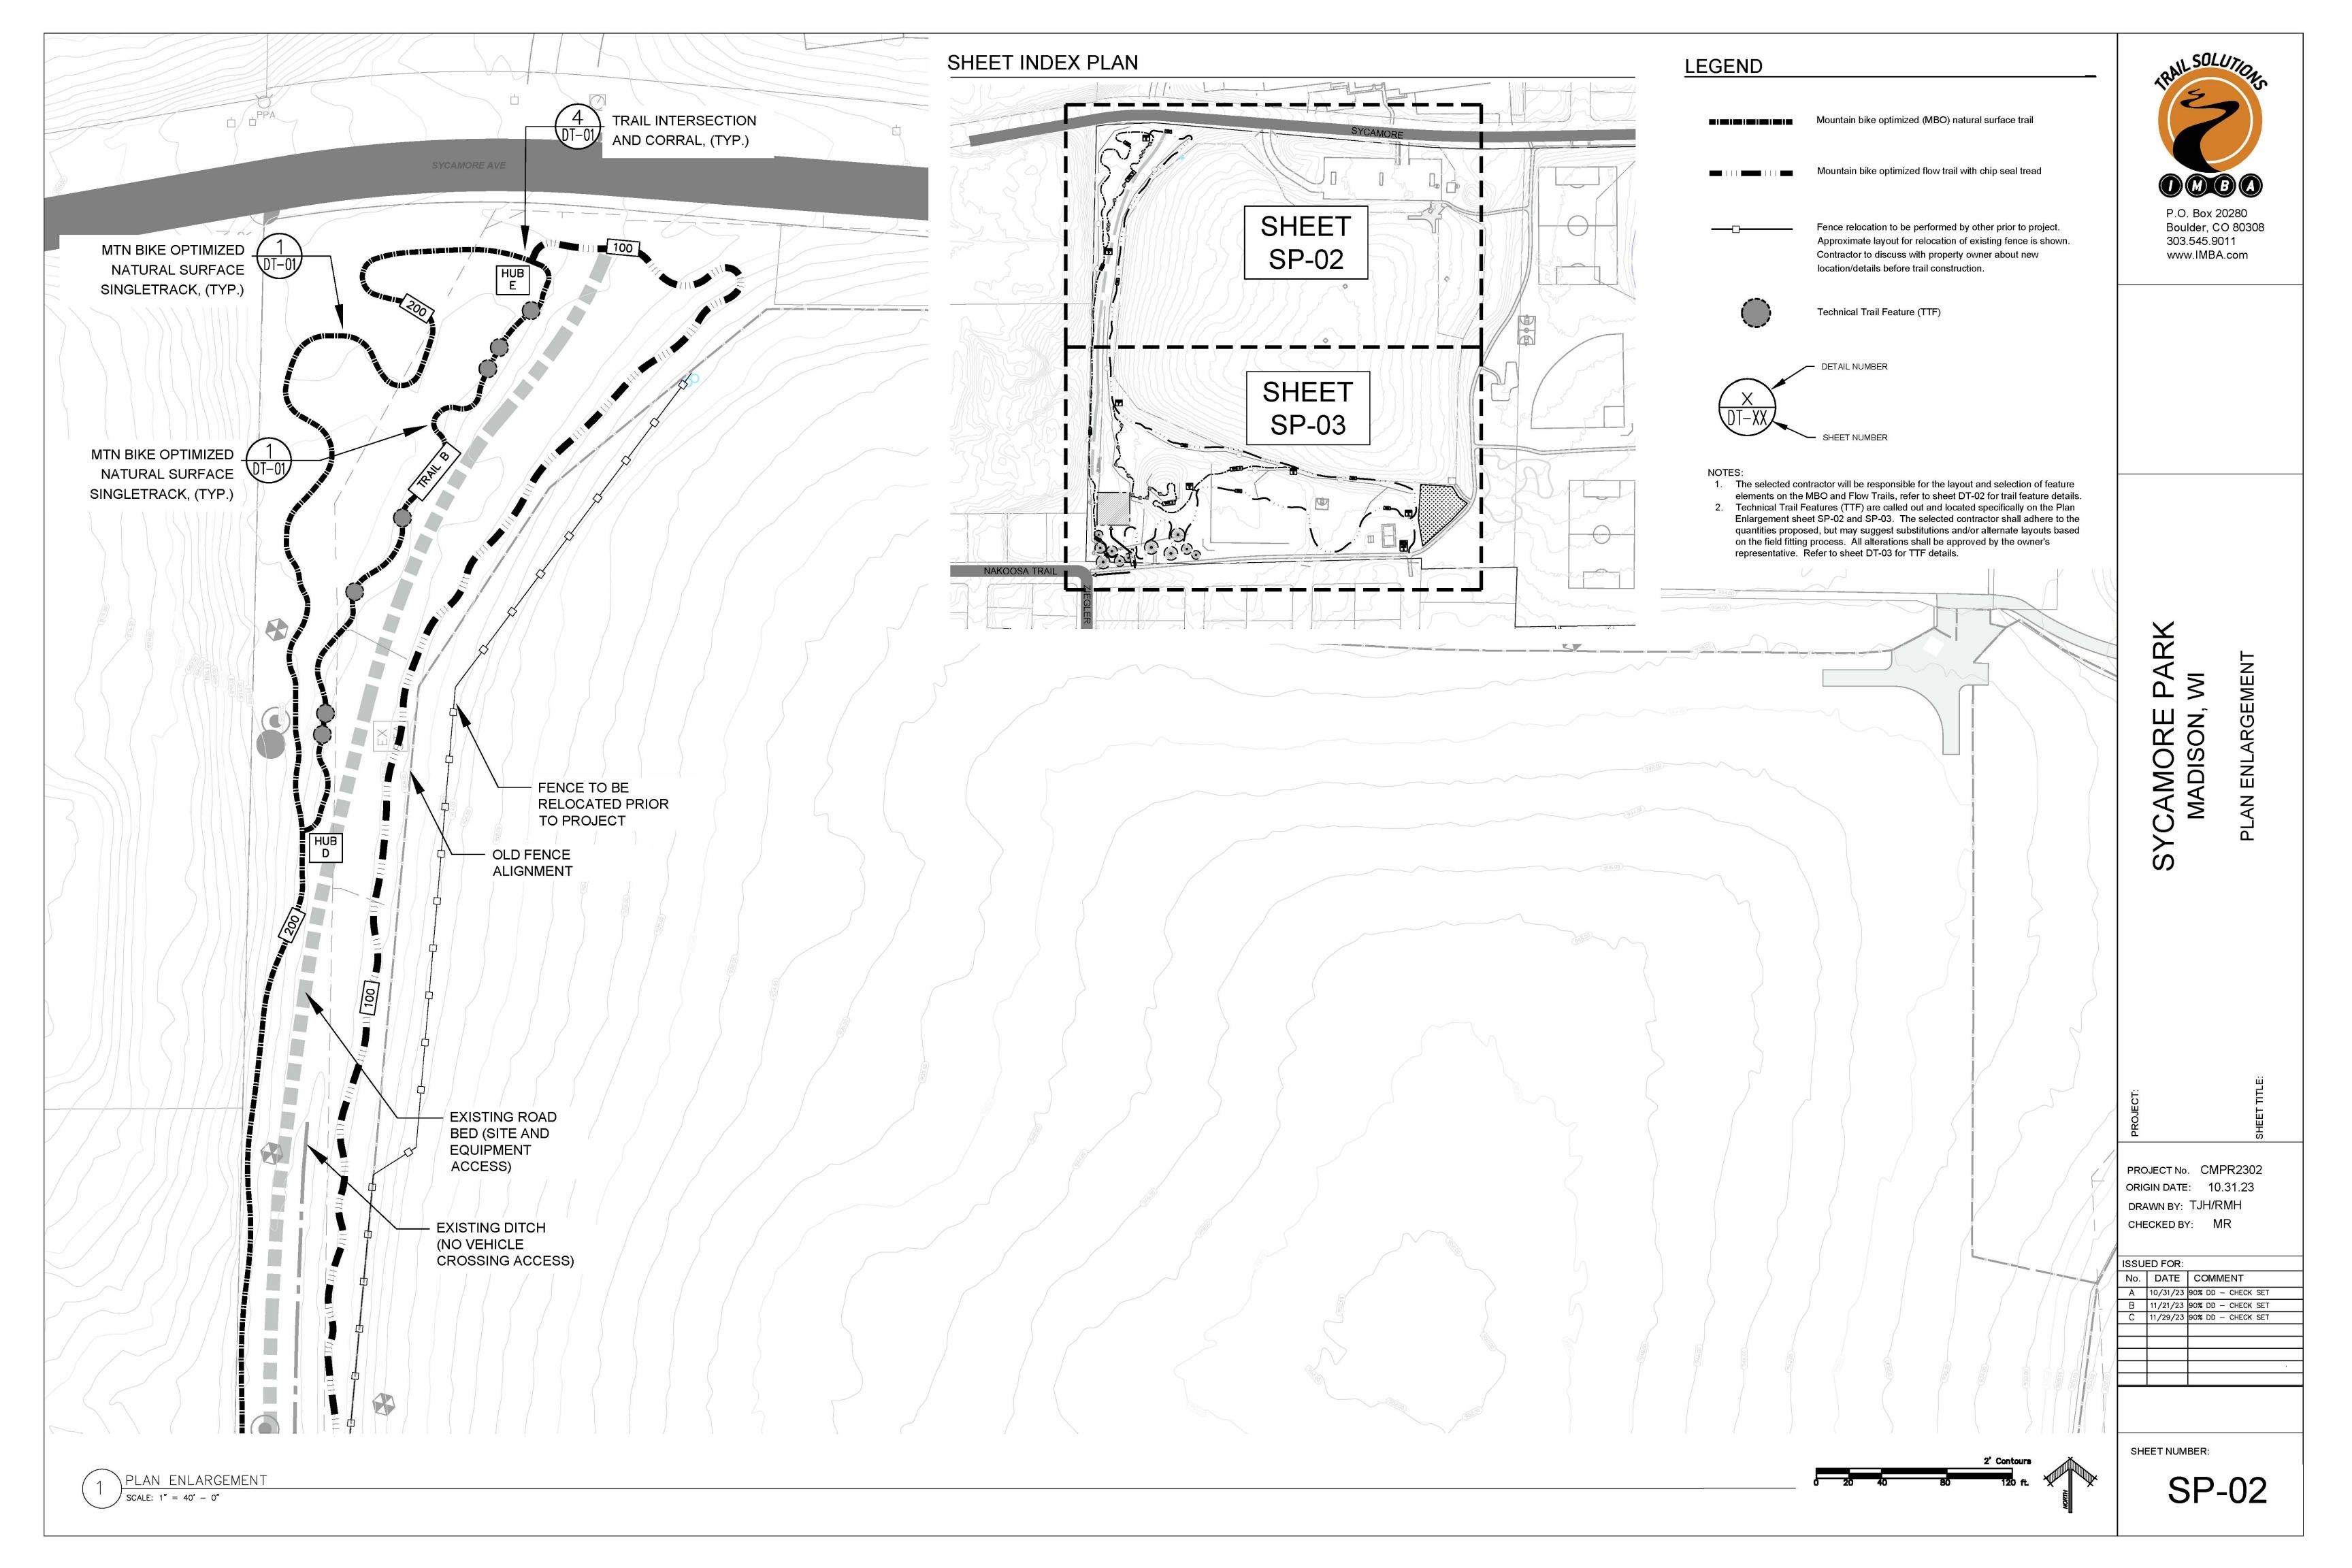

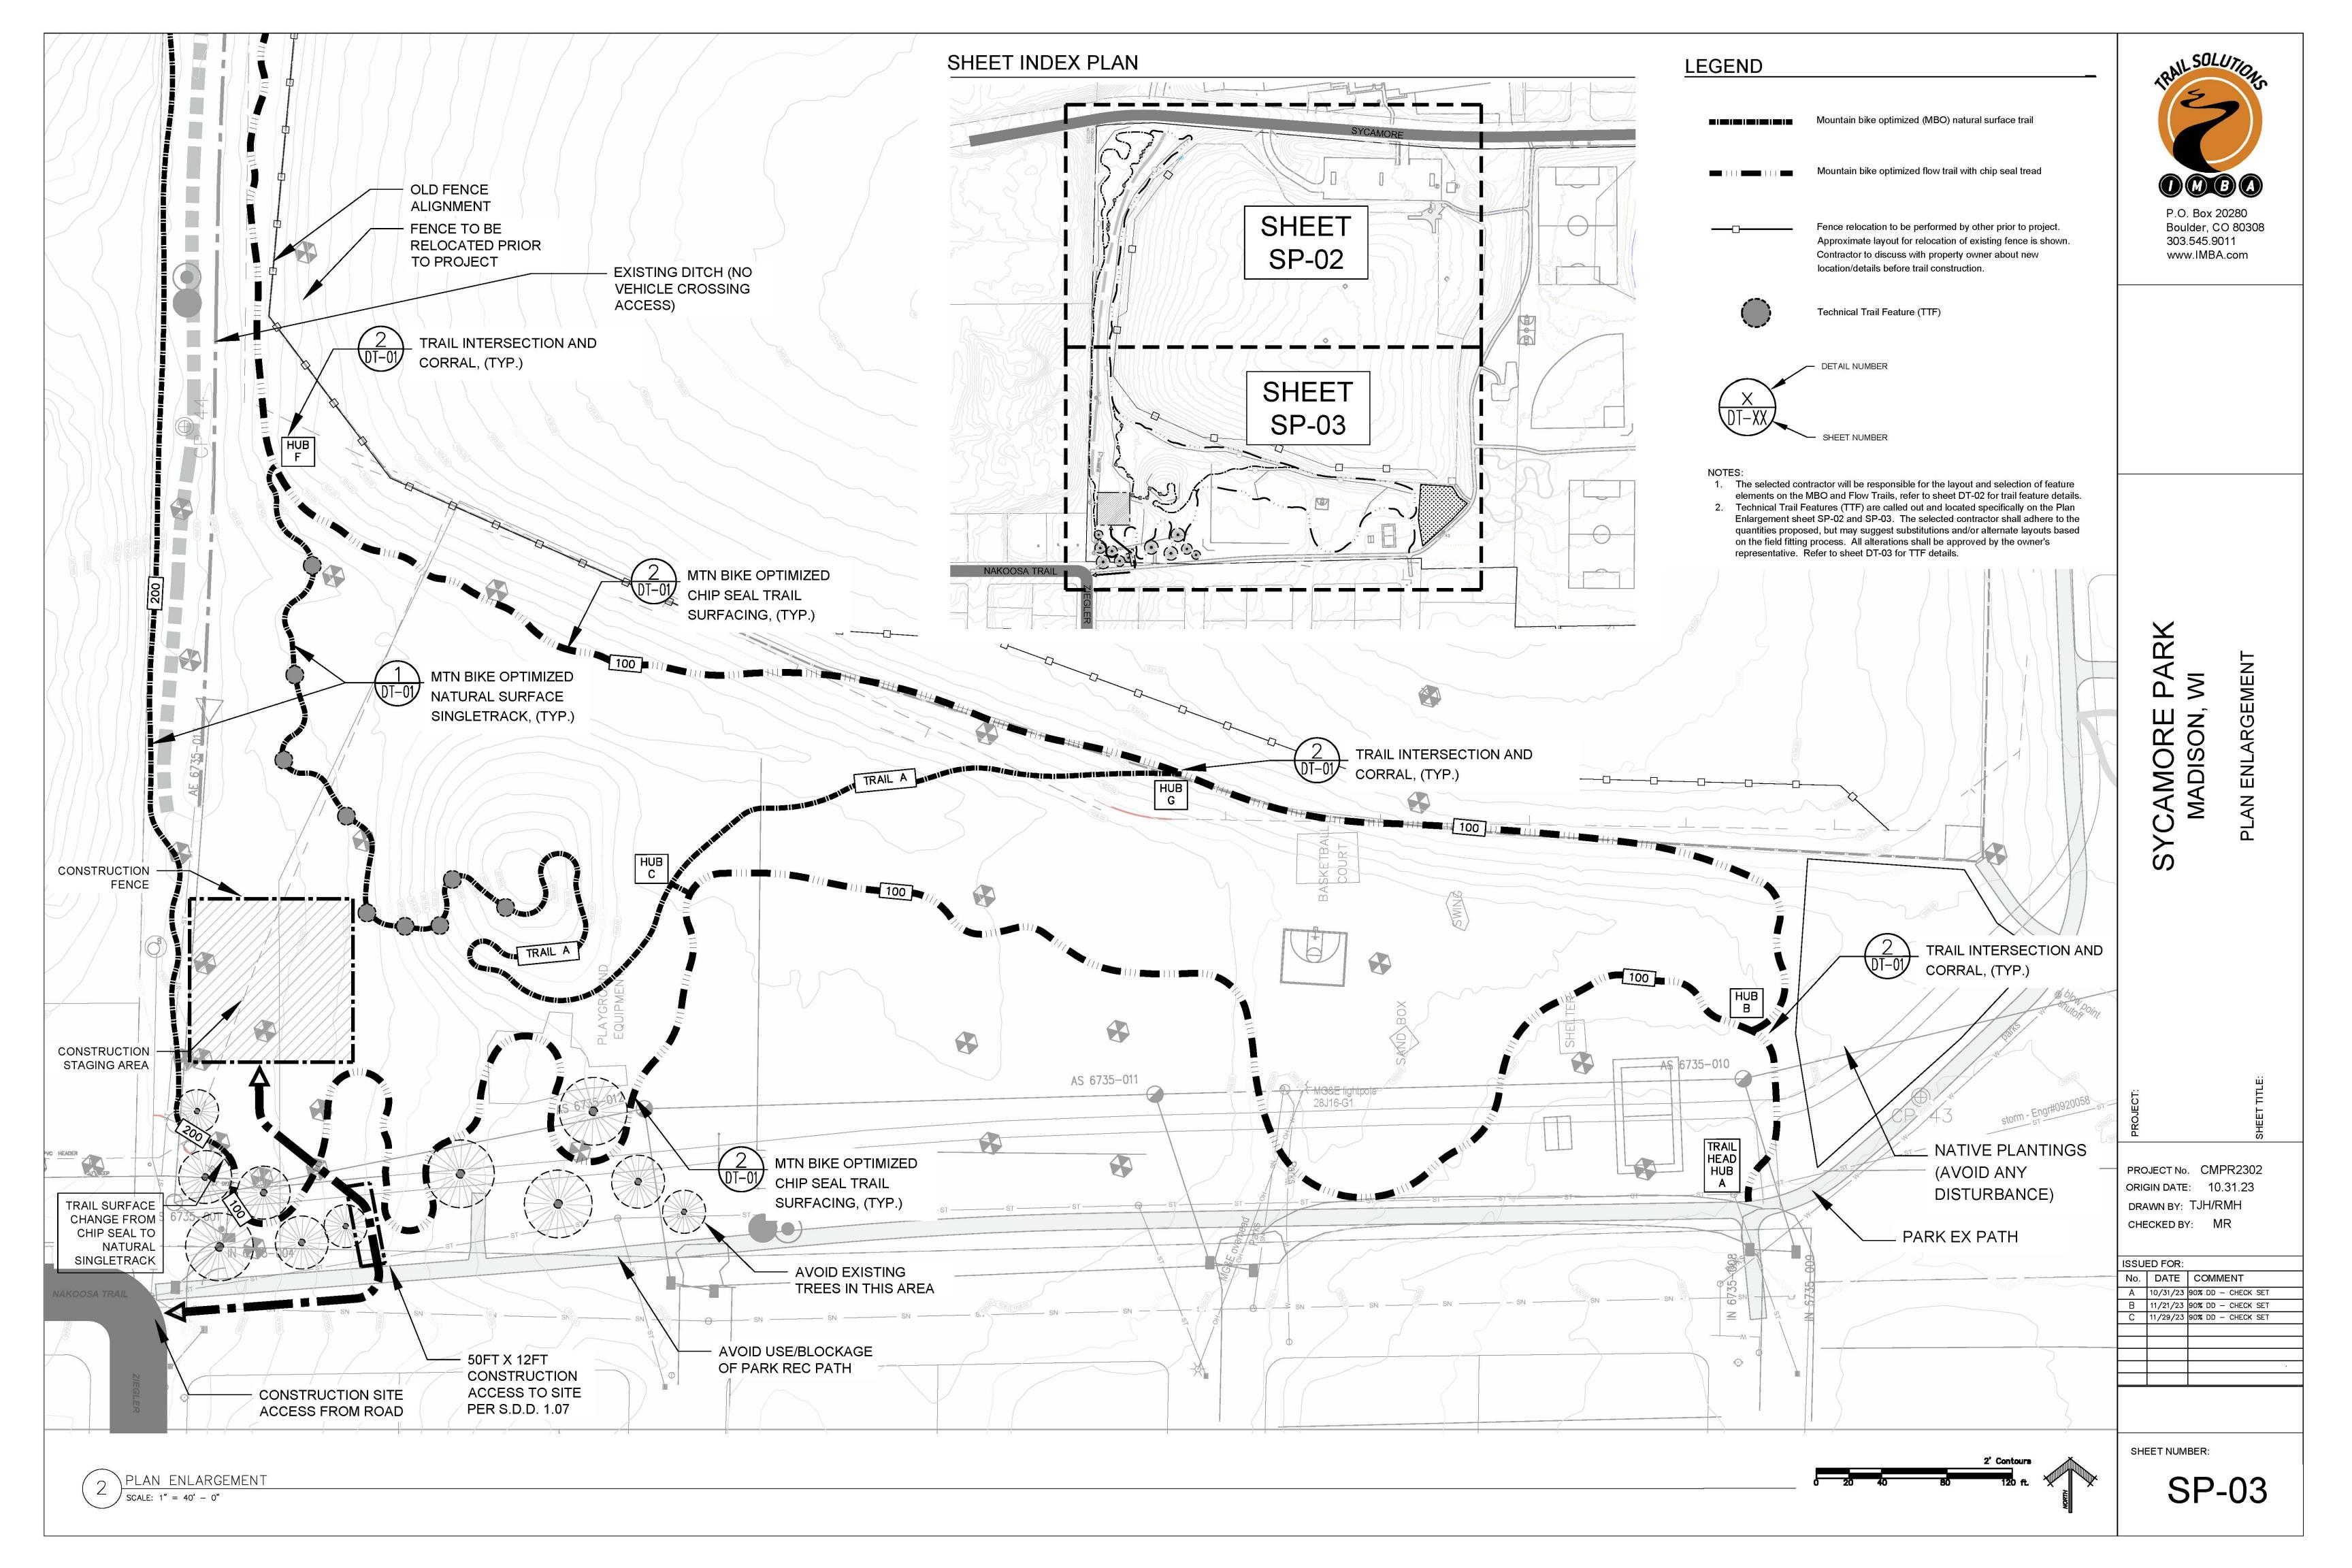

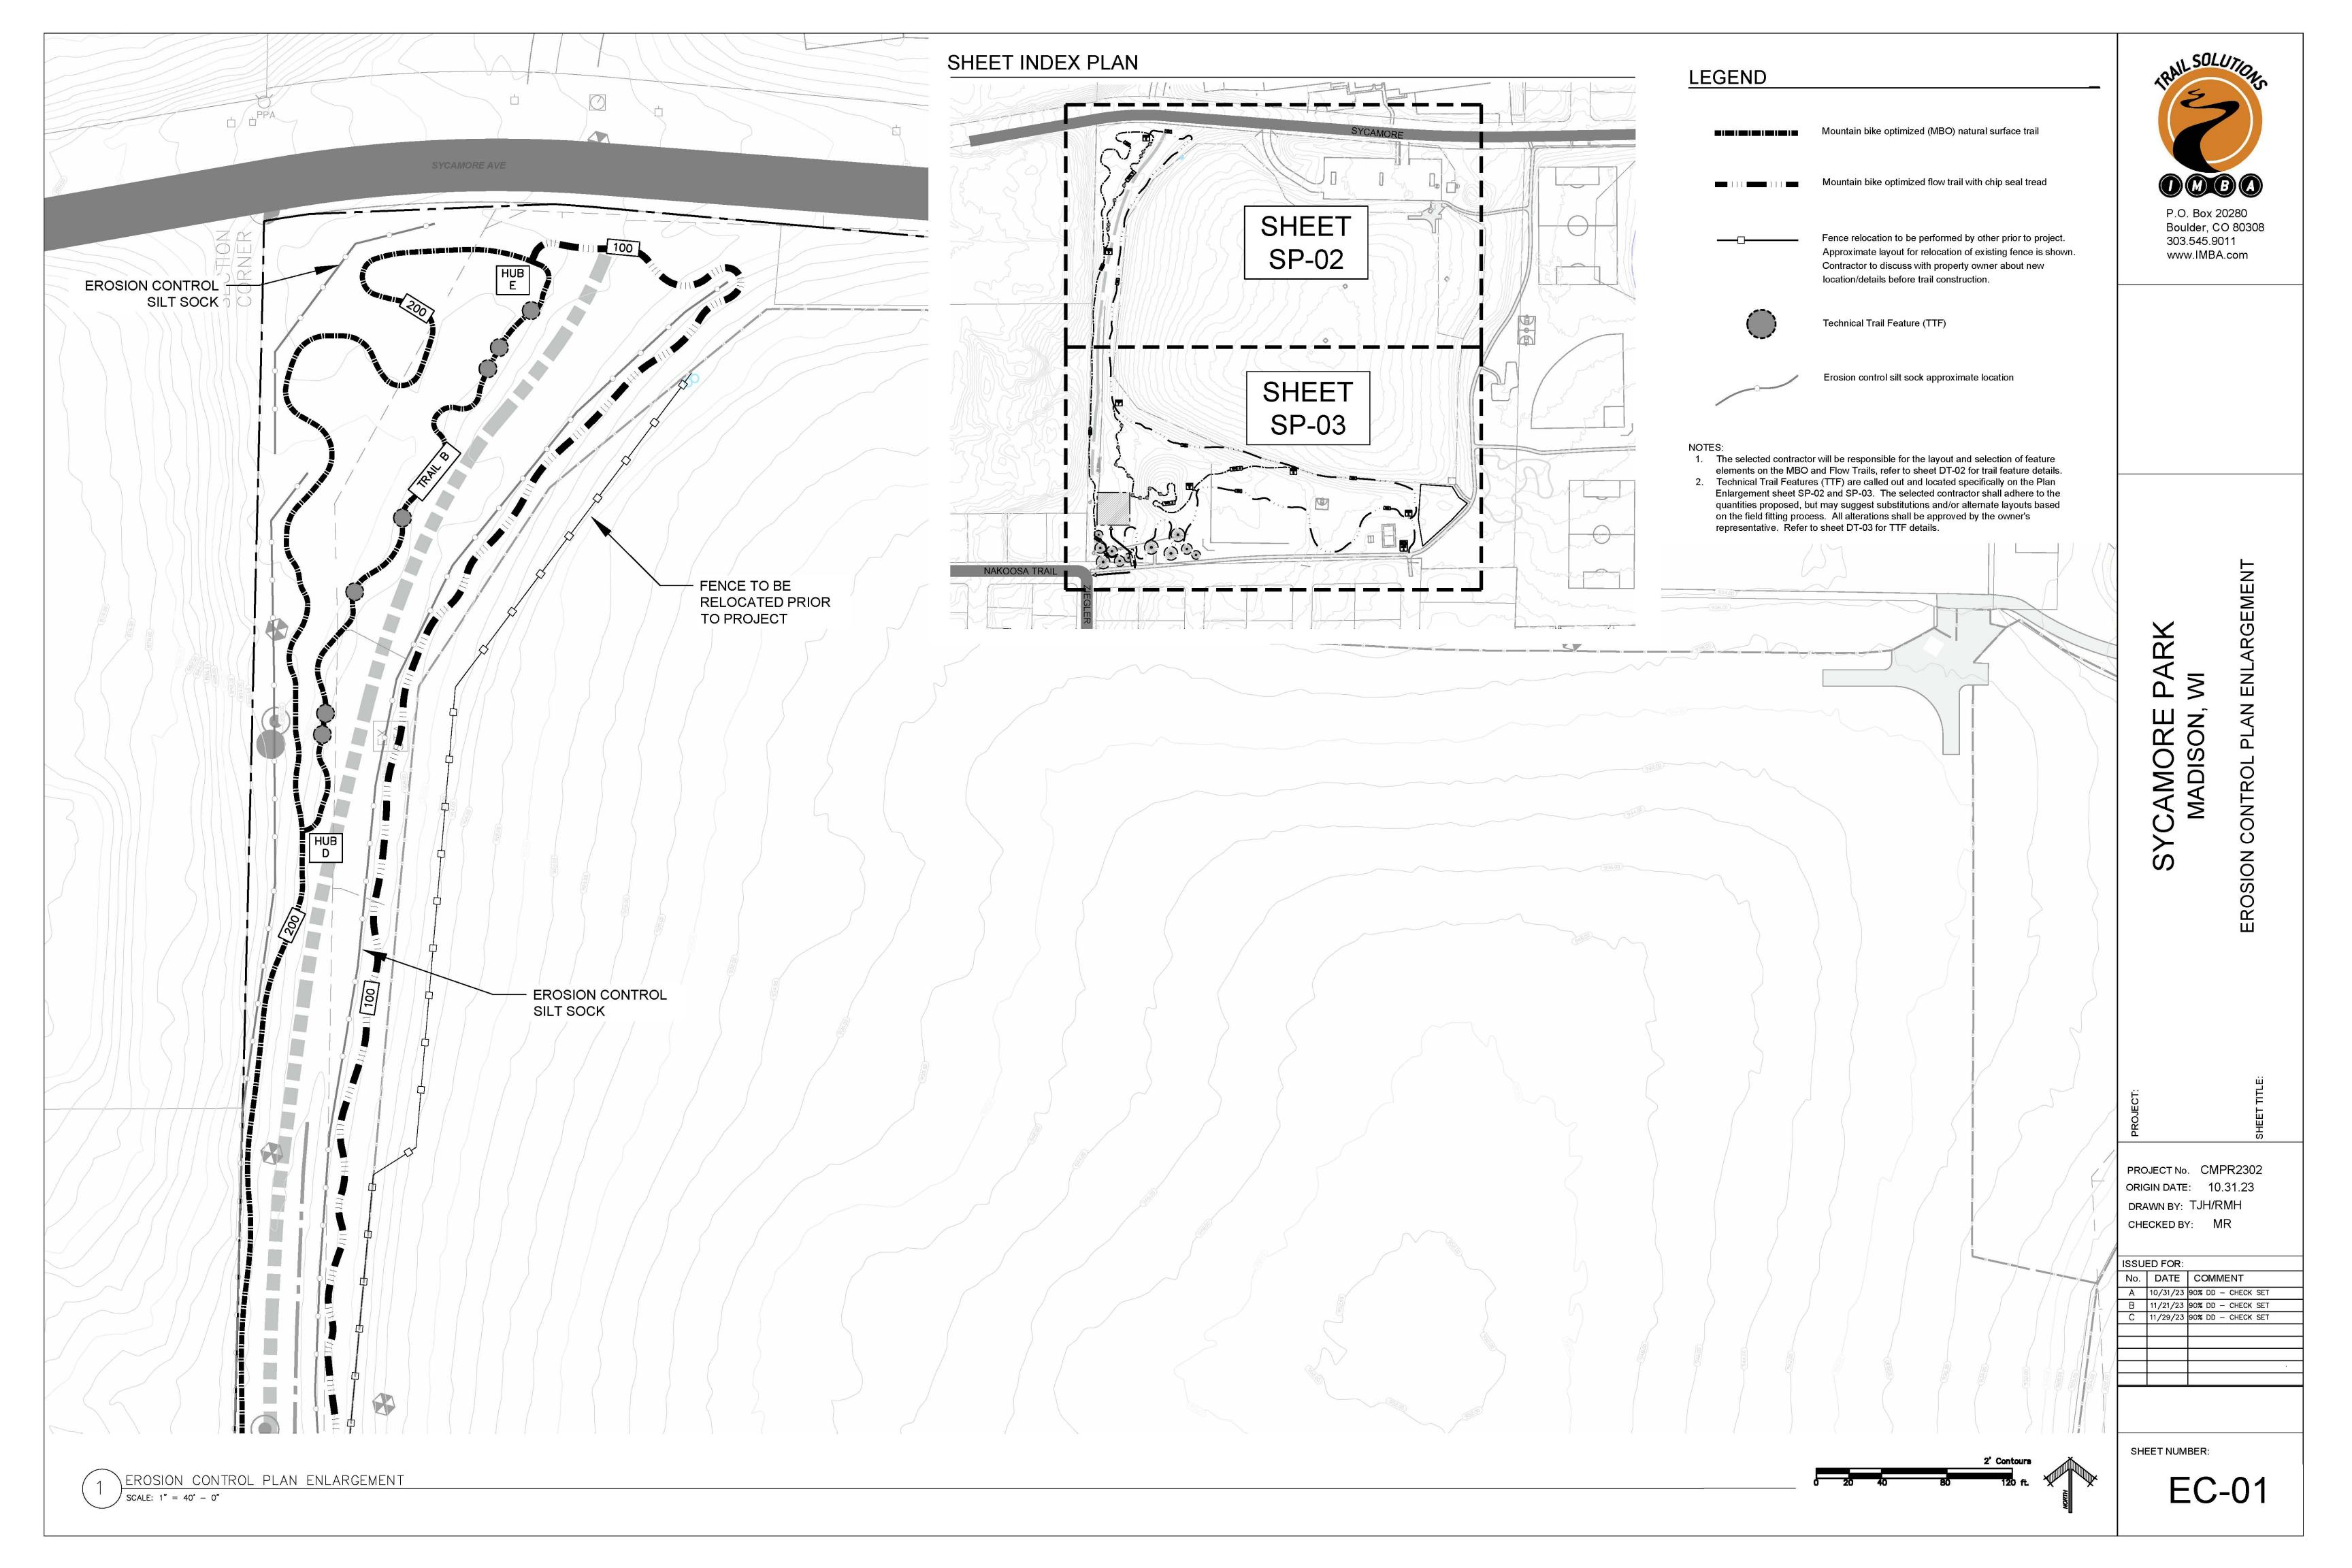


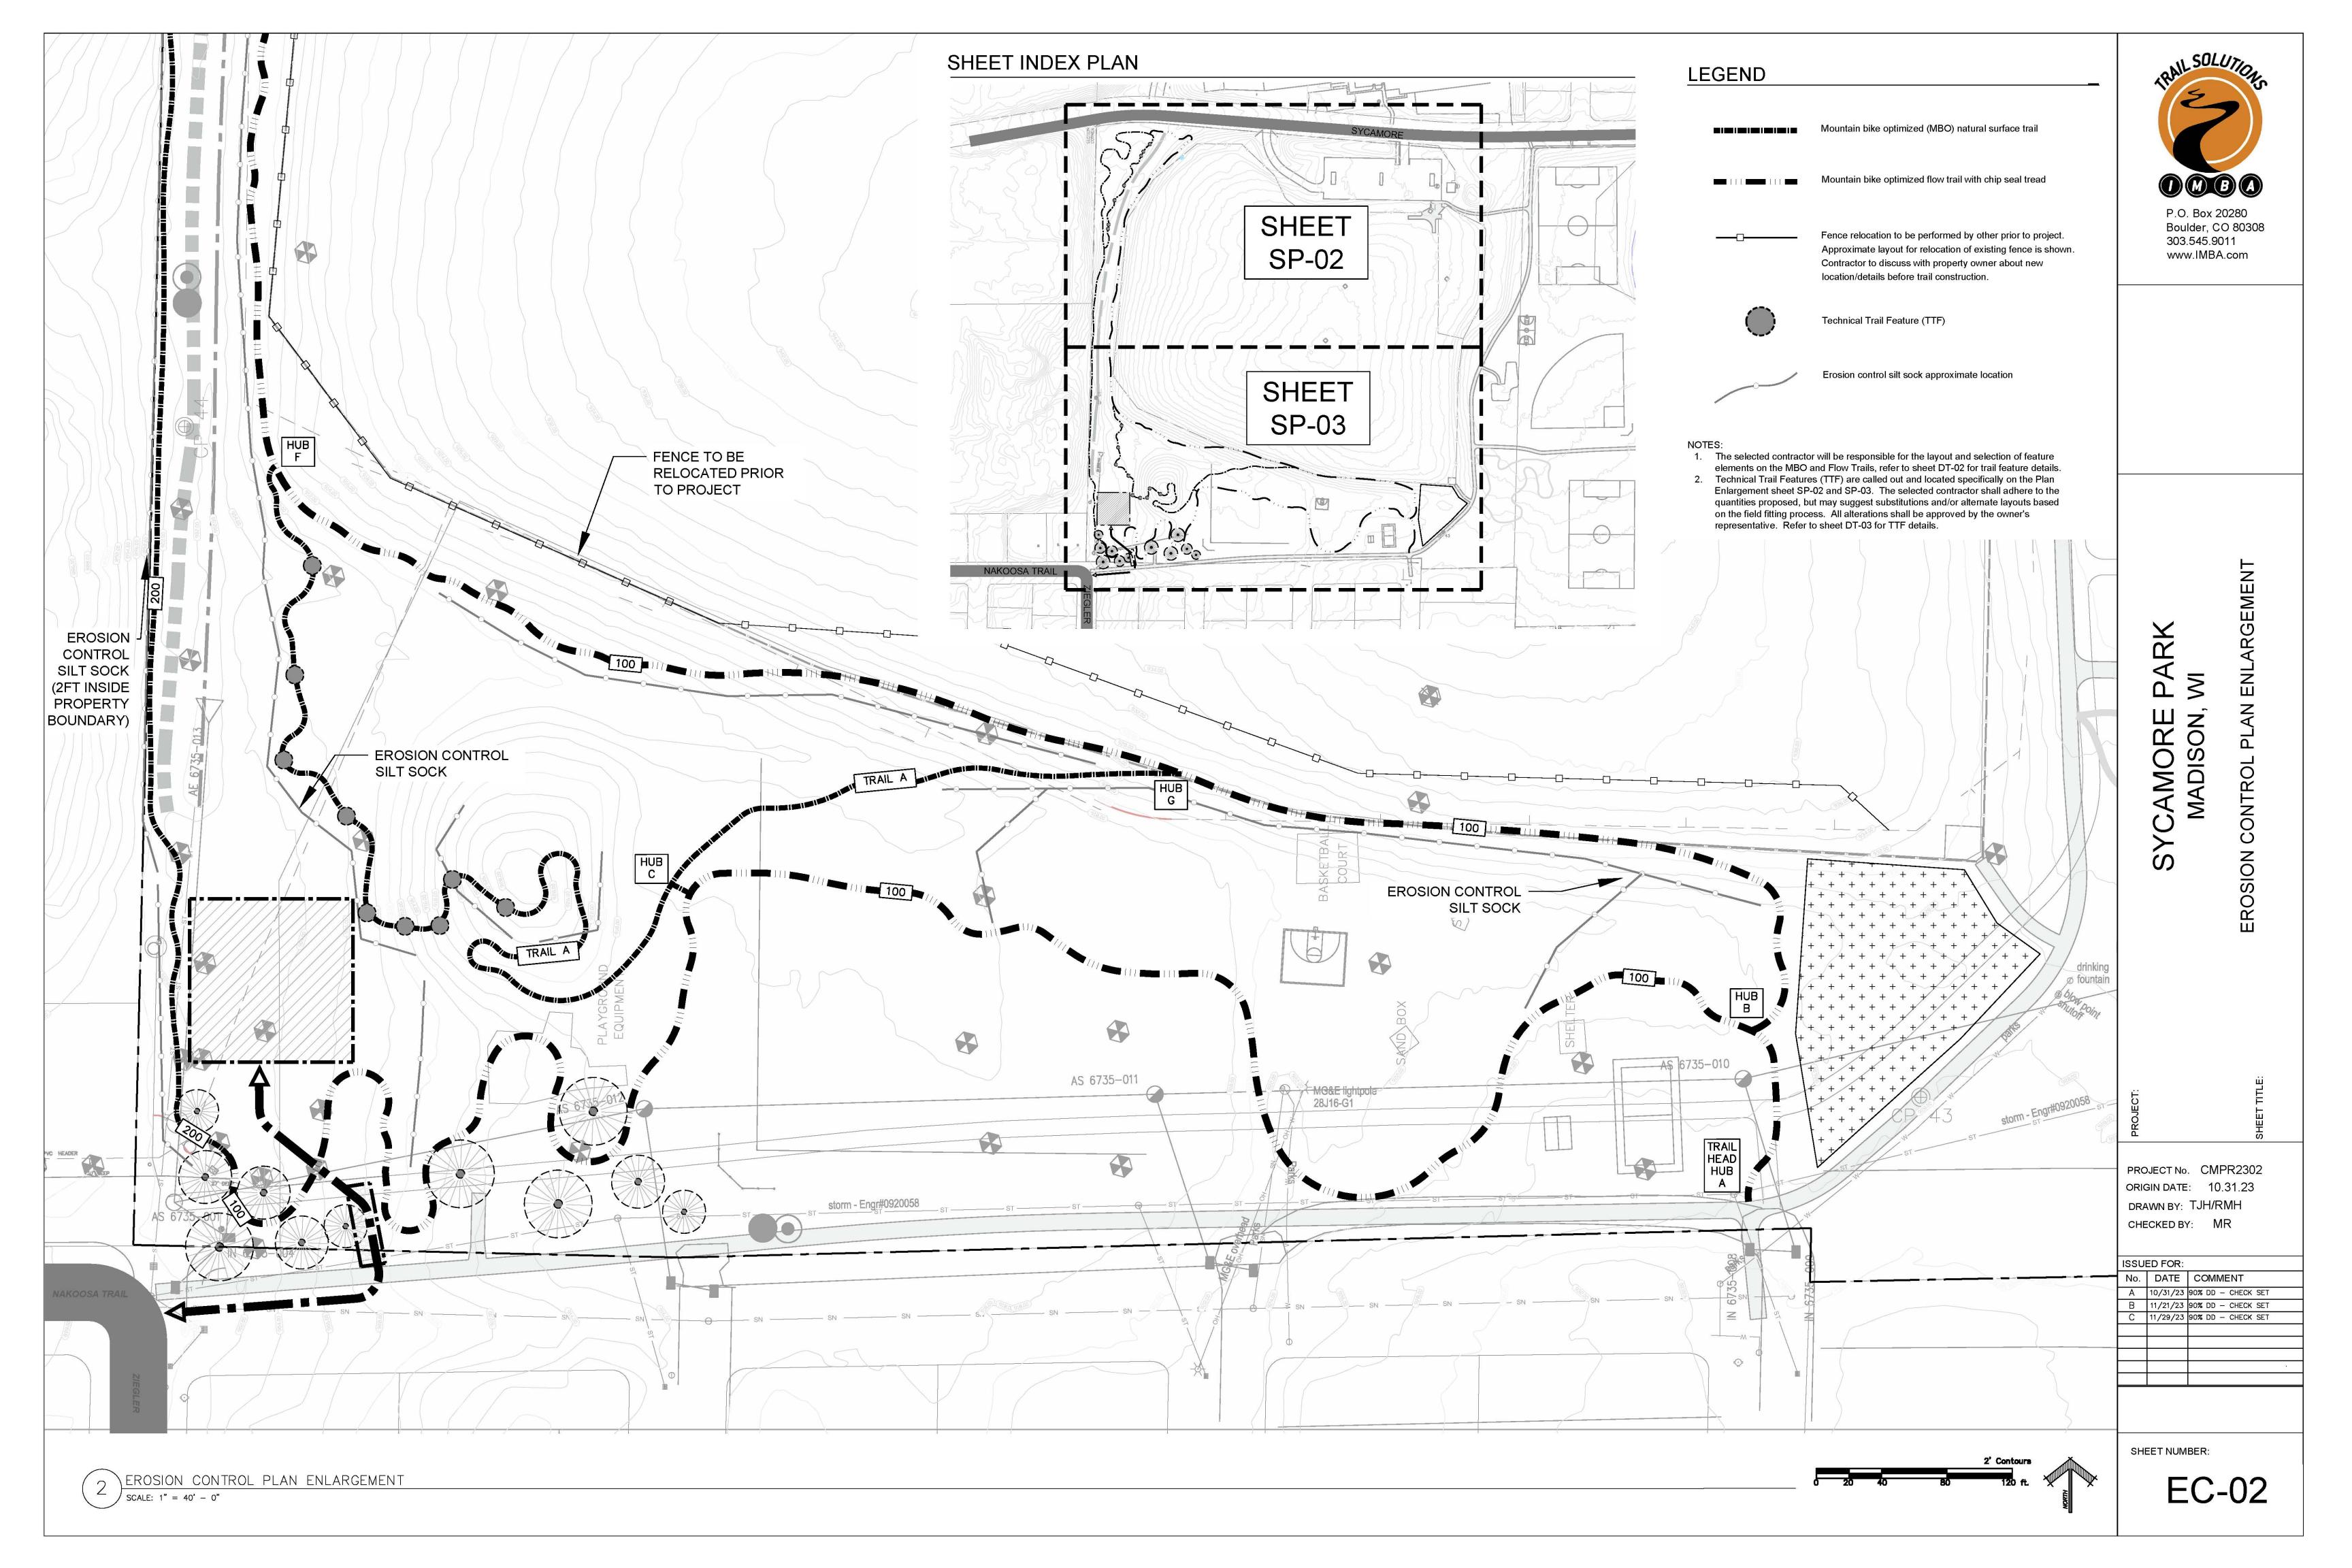

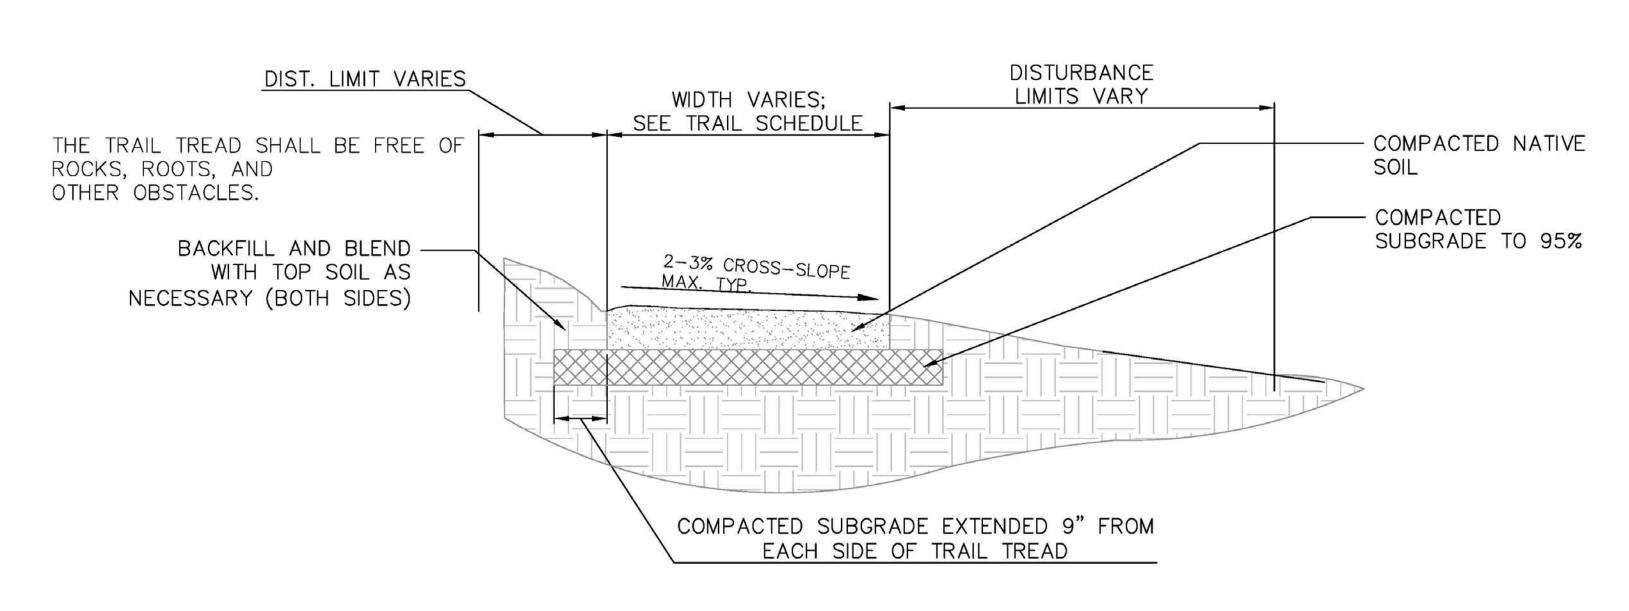


TYPICAL MOUNTAIN BIKE OPTIMIZED NATURAL SURFACE SINGLETRACK

SCALE: 3/4" = 1' - 0"

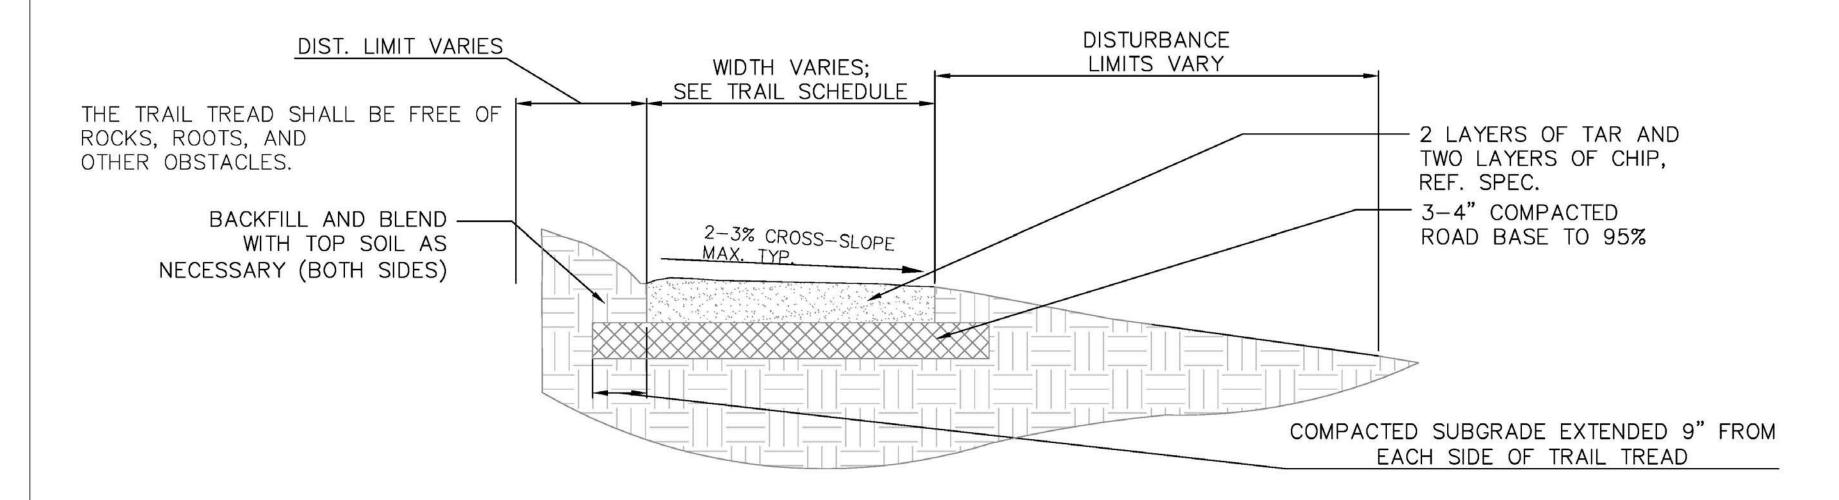

2 TYPICAL MOUNTAIN BIKE OPTIMIZED CHIP SEAL TRAIL

SCALE: 3/4" = 1' - 0"

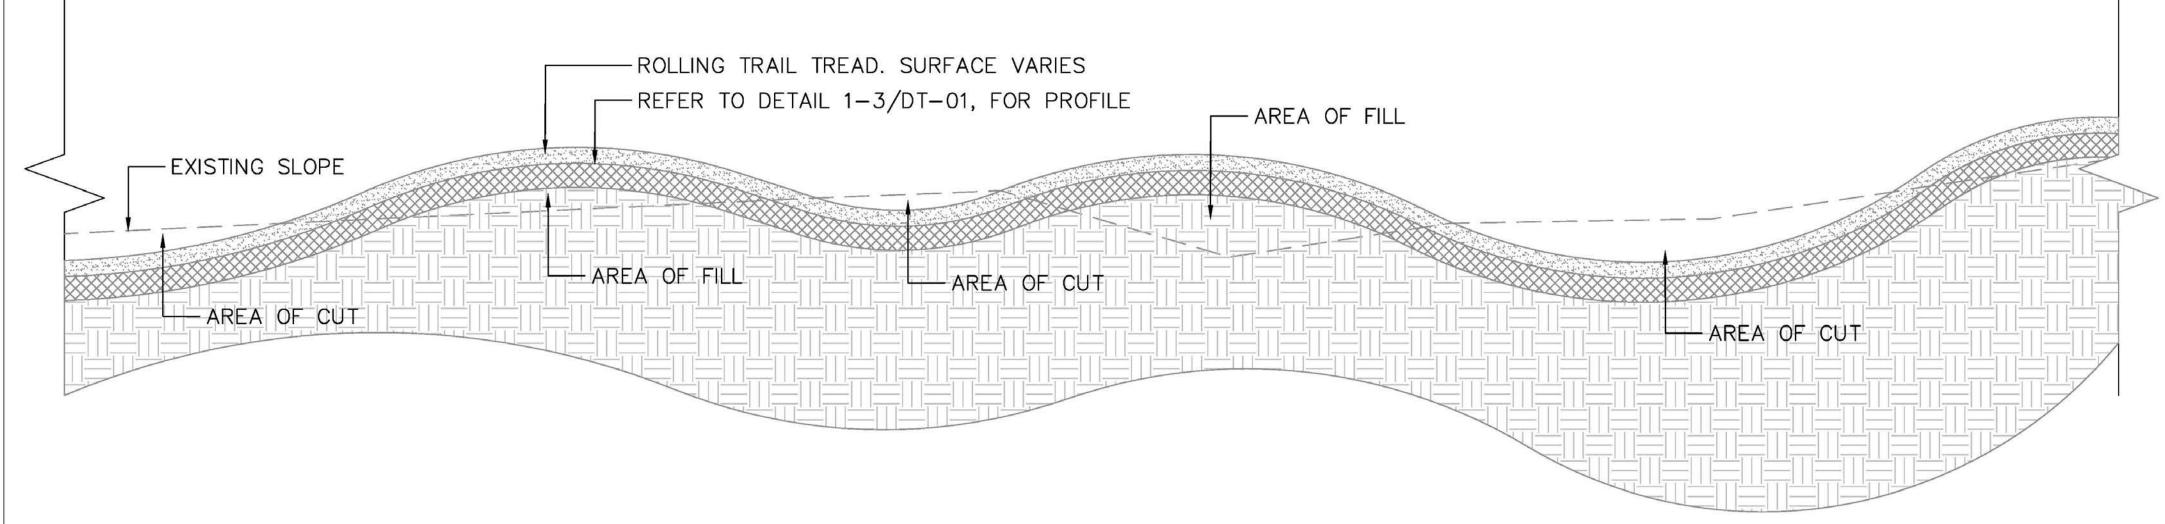

4 TYPICAL TRAIL INTERSECTION AND CORRAL SCALE: NTS

NOTE: SAMPLE TRAIL

INTERSECTION SHALL BE


CONSTRUCTED AND APPROVED

BY OWNER'S REPRESENTATIVE

PRIOR TO PROCEEDING WITH

REMAINING INTERESECTIONS.

Add rocks and low-growing
plants on either side of the

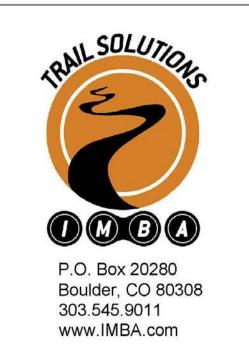

SYCAMORE PARK MADISON, WI

---Trail Intersection

PROJECT No. CMPR2302
ORIGIN DATE: 10.31.23
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Direction of travel

ISSUED FOR:

No. DATE COMMENT

A 10/31/23 90% DD - CHECK SET

B 11/21/23 90% DD - CHECK SET

A 10/31/23 90% DD - CHECK SET

11/21/23 90% DD - CHECK SET


11/29/23 90% DD - CHECK SET


SHEET NUMBER:

DT-01


TYPICAL MOUNTAIN BIKE OPTIMIZED SINGLETRACK SECTION


SCALE: 3/4" = 1' - 0"

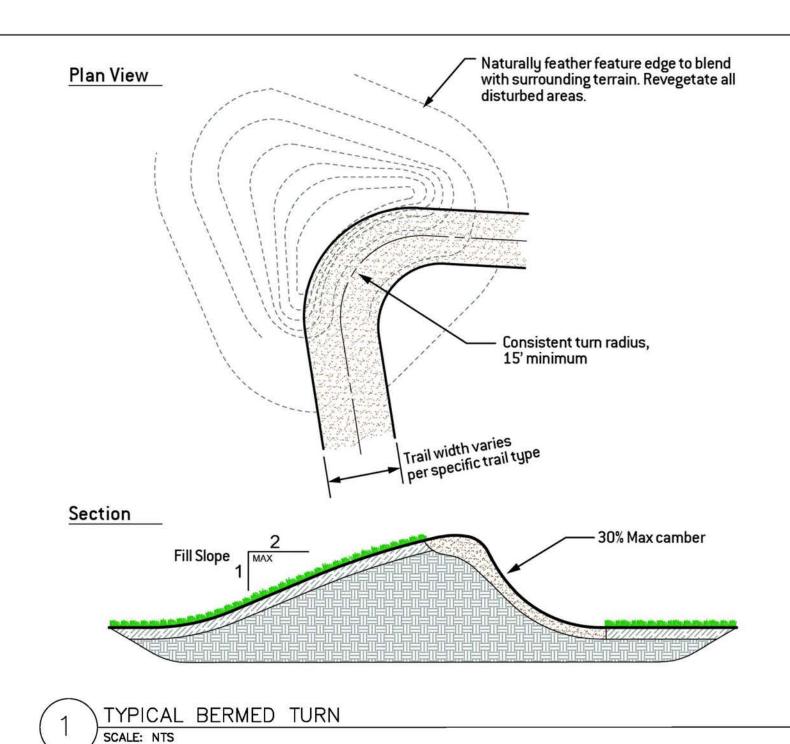


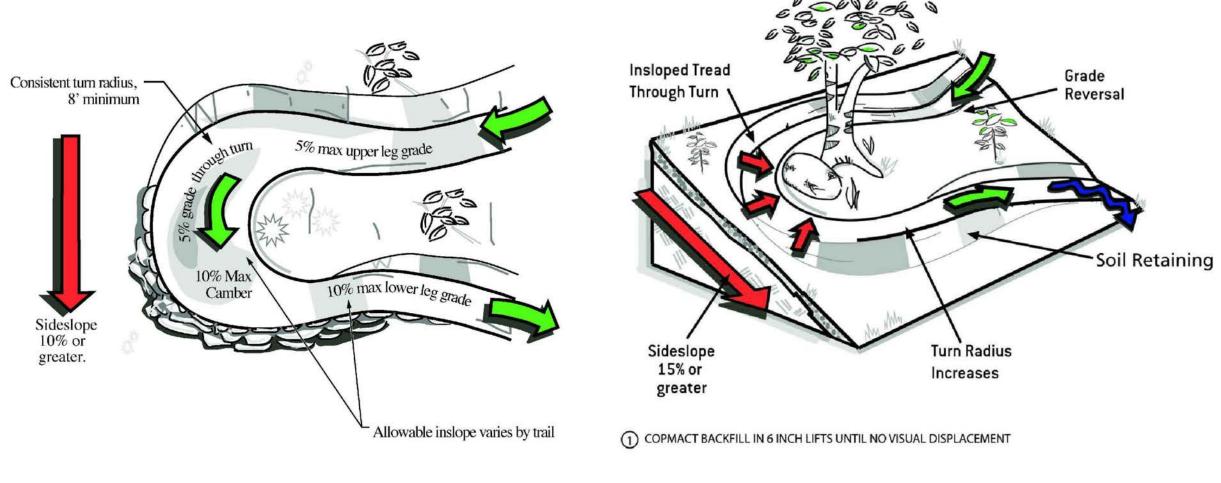

2 TYPICAL ELEVATED PLATFORM TURN SCALE: NTS

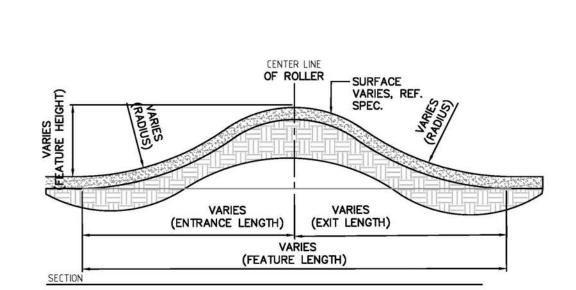

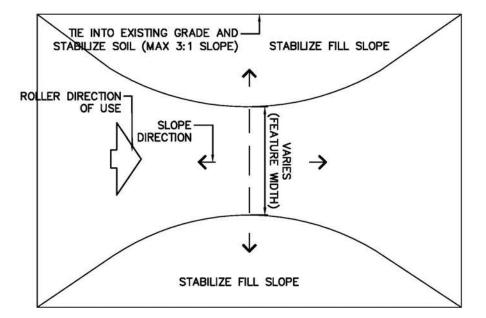


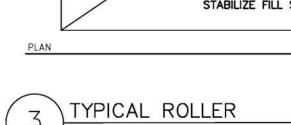


SCALE: NTS

Roller dimen	sion ranges		
Difficulty	Height (ft)	Length (ft)	Width (ft)
Beginner	0.5' - 2'	10' - 15'	3' - 5'
Intermediate			
and above	1' - 3'	10' - 20'	3' - 6'

NOTE: REFER TO TRAIL LEGEND FOR FEATURE FREQUENCY

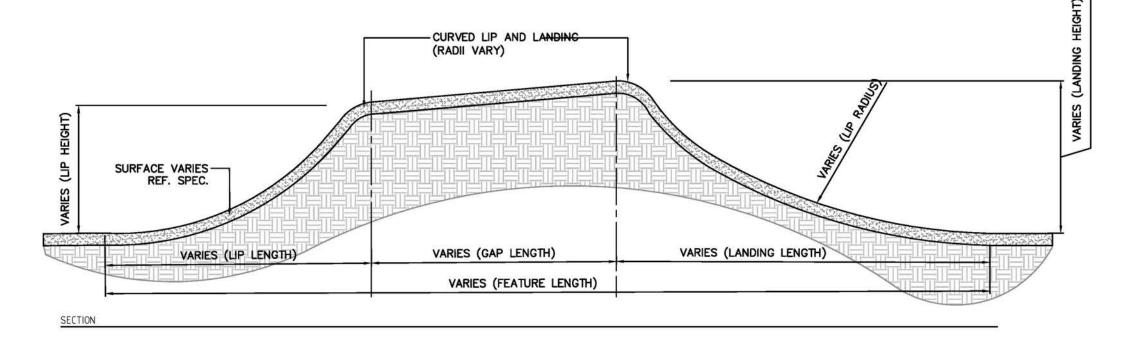

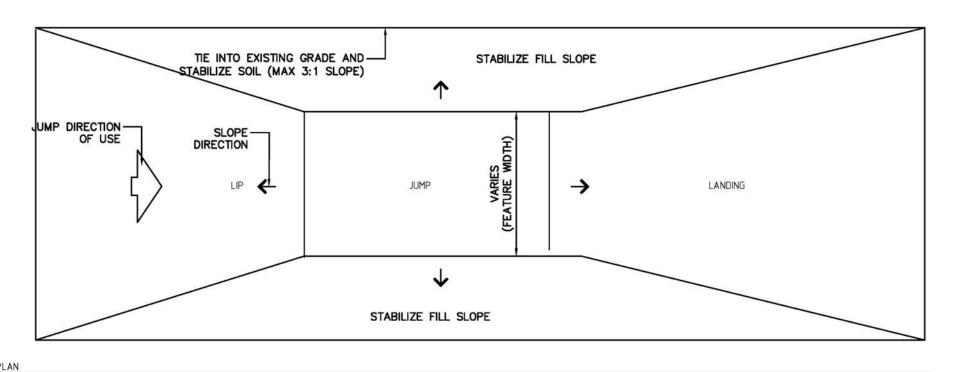



4 TYPICAL TABLETOP JUMP

Jump dimension ranges

Difficulty	Height (ft)	Length (ft)	Width (ft)
Beginner	2' - 3'	25 ' -35'	4' - 6'
Intermediate	3' - 5'	30' - 40'	4' - 6'
Advanced	4' - 7'	20' - 50'	4' - 6'

NOTE: REFER TO TRAIL LEGEND FOR FEATURE FREQUENCY

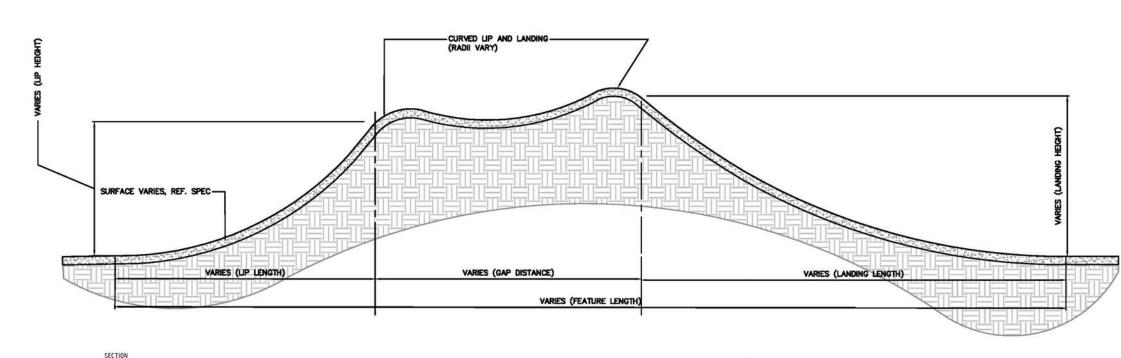

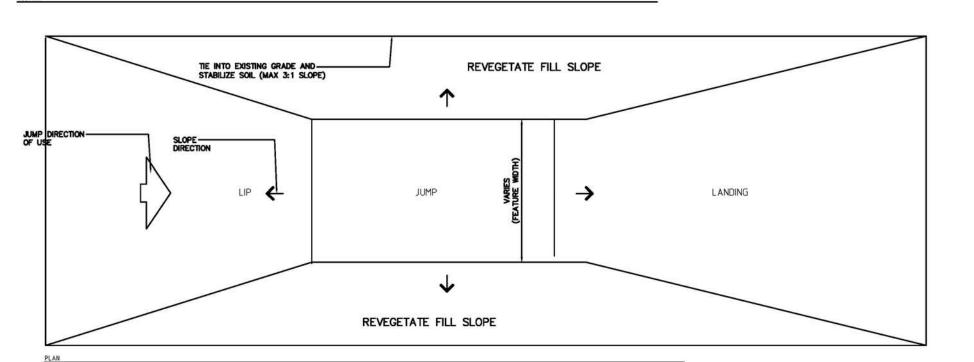

5 TYPICAL ROLLABLE GAP JUMP scale: NTS

Jump dimension ranges

Difficulty	Height (ft)	Length (ft)	Width (ft)
Beginner	2' - 3'	25 ' -35'	4' - 6'
Intermediate	3' - 5'	30' - 40'	4' - 6'
Advanced	4' - 7'	20' - 50'	4' - 6'

NOTE: REFER TO TRAIL LEGEND FOR FEATURE FREQUENCY



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TTLE:
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SHEET

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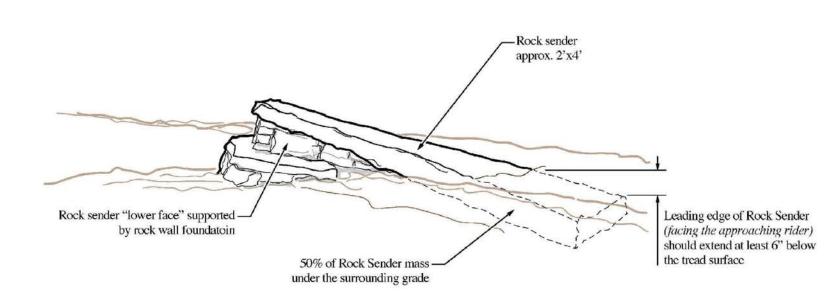
	The state of the s	COMMENT
Α	10/31/23	90% DD - CHECK SET
В	11/21/23	90% DD - CHECK SET
C	11/29/23	90% DD - CHECK SET

SHEET NUMBER:

DT-02

NOTE: A 48" bypass of trail tread shall be provided around each feature.











4 TYPICAL ROCK SENDER (SMALL)
SCALE: NTS

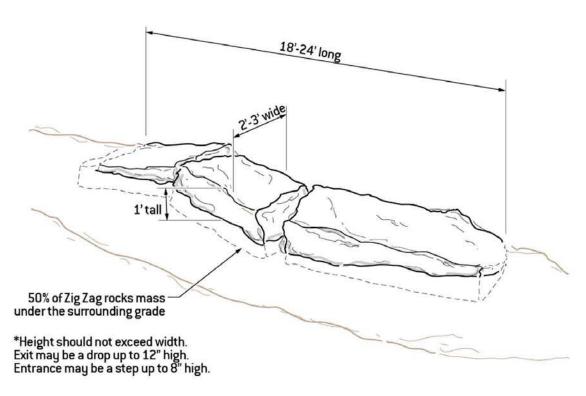


NOTE: A 48" bypass of trail tread shall be provided around each feature.




Plan View

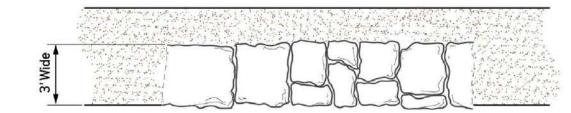


Section

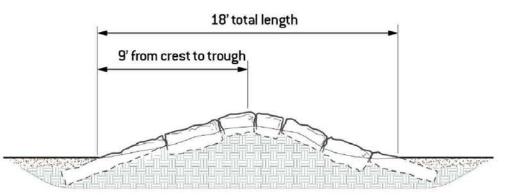


NOTE: A 48" bypass of trail tread shall be provided around each feature.

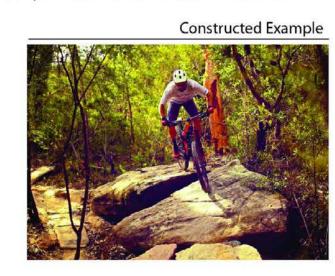



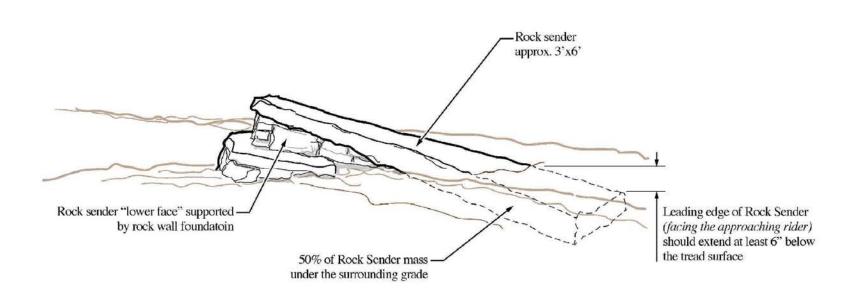



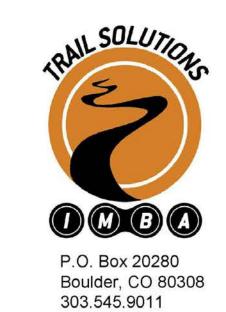

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DRAWN BY: TJH/RMH
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SHEET NUMBER:

DT-03